● State

March 14, 2007

RE: Summit Operating, LLC Marie 666

Sec. 19, T10S, R24E

Utah Division of Oil, Gas and Mining 1549 West North Temple, Suite 1210 Salt Lake City, UT 84114

Dear Sir or Madam,

Summit Operating, LLC respectfully requests a spacing exception for the subject location. The well has been moved from the center of the forty-acre spacing.

The well is located at 539' FSL & 1719' FWL, which has changed from the proposed location at 660' FSL & 1980' FWL.

The location was moved due to topography, drainages and access to the center of the forty.

Summit Operating, LLC is the only lease owner within a 460 foot radius.

If you have additional questions, please feel free to contact me.

Best regards,

Ginger Stringham PO BOX 790203

Vernal, UT 84079

435-789-4162

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DIV. OF OIL, GAS & MINING


UNITED_STATES			OMB No. 10 Expires Marc	004-0137 ch 31, 2007
DEPARTMENT	DEPARTMENT THE INTERIOR BUREAU OF LAND MANAGEMENT			
APPLICATION FOR PERMIT TO			6. If Indian, Allotee or	Triba Nama
AT LIGHTON TON PERMIT TO	UNILL OR REENTER		in motest rindles (ii	Title Name
la. Type of work:	ER		7. If Unit or CA Agreem	ent, Name and No.
lb. Type of Well: Oil Well ✓ Gas Well Other	Single Zone V Mul	ltiple Zone	8. Lease Name and We Marie 666	II No.
Name of Operator Summit Operating LLC	hermand	pre Zene	9. API Well No .	7.44
3a. Address PO BOX 683909 Park City, UT 84068	3b. Phone No. (include area code) 435-940-9001		10. Field and Pool, or Exp	0 47-39154 ploratory
Location of Well (Report location clearly and in accordance with at At surface		128753	Natural Buttes 11. Sec., T. R. M. or Blk.	and Survey or Area
At proposed prod. zone Same as above	nt, State requirements *1 39. 4 648753X 4421090Y-109.	259242	Sec. 19, T10S. R	24E
14. Distance in miles and direction from nearest town or post office* 66 miles southeasterly of Vernal, UT			12. County or Parish Uintah	13. State
15. Distance from proposed* location to nearest property or lease line, fi.	16. No. of acres in lease	17. Spacir	ng Unit dedicated to this wel	UT
(Also to nearest drig. unit line. if any)	1,278.08	40 Ac	cres	
18. Distance from proposed location* to nearest well, drilling, completed, applied for, on this lease, ft. 2,300'	19. Proposed Depth 7,050		BIA Bond No. on file	
21. Elevations (Show whether DF, KDB, RT, GL, etc.) 5.184 GL	22 Approximate date work will s		23. Estimated duration	
5,104 OE	03/15/2007		30 Days	
The following, completed in accordance with the requirements of Onsho	24. Attachments			
 Well plat certified by a registered surveyor. A Drilling Plan. A Surface Use Plan (if the location is on National Forest System SUPO must be filed with the appropriate Forest Service Office). 	4. Bond to cover Item 20 above 5. Operator certifications 1.	r the operation).	ons unless covered by an ex-	
25. Signature	Name (Printed Typed)		D	ate
Title Agent ()	Ginger Stringham			03/15/2007
Applyoted by Standyre	Name (Printed Typed) BRADLEY	G HII	E)ate 03-28-0
Title	OffichVIRONMENT	AL MANAG	GER	03 050
Application approval does not warrant or certify that the applicant hole conduct operations thereon. Conditions of approval, if any, are attached.	ds legal or equitable title to those ri	ghts in the sul	bject lease which would ent	itle the applicant to
Title 18 U.S.C. Section 1001 and Title 43 U.S.C. Section 1212, make it a States any false, fictitious or fraudulent statements or representations a	crime for any person knowingly an as to any matter within its jurisdiction	d willfully to i	make to any department or	agency of the United
*(Instructions on page 2)	v			

"(Instructions on page 2)

Federal Approval of this Action is Necessary

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T10S, R24E, S.L.B.&M.

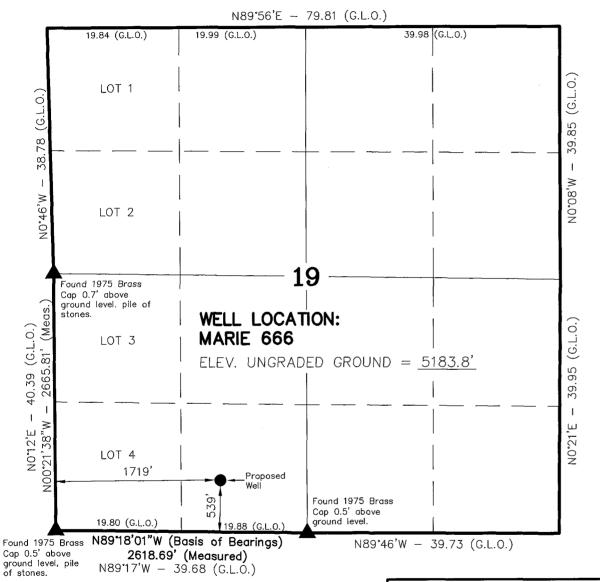

▲ = SECTION CORNERS LOCATED


BASIS OF ELEVATION IS BENCH MARK 87 EAM 1965 LOCATED IN THE SE 1/4 SW 1/4 OF SECTION 1, T12S, R23E, S.L.B.&M. THE ELEVATION OF THIS BENCH MARK IS SHOWN ON THE ARCHY BENCH SE 7.5 MIN. QUADRANGLE AS BEING 5887'.

Marie 666 (Proposed Well Head) NAD 83 Autonomous

LATITUDE = 39° 55′ 43.26″ LONGITUDE = 109° 15′ 35.73″

SUMMIT OPERATING, LLC

WELL LOCATION, MARIE 666, LOCATED AS SHOWN IN THE SE 1/4 SW 1/4 OF SECTION 19, T10S, R24E, S.L.B.&M. UINTAH COUNTY, UTAH.

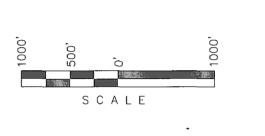

NOTES:

- 1. Well footages are measured at right angles to the Section Lines.
- 2. Bearings are based on Global Positioning Satellite observations.

THIS IS TO CERTIFY THAT THE BOYE PLAT WAS PREPARED FROM FIELD OF THE BURNEYS MADE BY ME OR UNDER MY SUPERIOR AND THAT THE SAME ARE TRUE ON DOCORREST, TO THE BEST OF MY KNOWLEDGE AND SELECTION 162251

REGISTER D. ARD SHAPE YORK REGISTRA ROMAN STATE OF URBERT OF THE OF THE

TIMBERLINE LAND SURVEYING, INC.

38 WEST 100 NORTH. - VERNAL, UTAH 84078 (435) 789-1365

DATE SURVEYED: 02-27-07	SURVEYED BY: M.S.B.	SHEET
DATE DRAWN: 02-28-07	DRAWN BY: M.W.W.	2
SCALE: 1" = 1000'	Date Last Revised:	OF 10

Ten Point Plan

Summit Operating LLC

Marie 666

Surface Location SE 1/4 SW 1/4,

Section 19, T10S. R24E.

1. Surface Formation Green River

2. Estimated Formation Tops and Datum:

Formation		Depth	Subsea
Green River		Surface	+5,184°G.R.
Wasatch	Oil/Gas	2,784	+2,400
Mesa Verde	Oil/Gas	4,522	+ 662
Castlegate	Oil/Gas	6.722'	-1,538
TD		7,050`	-1.738

All fresh water prospectively valuable minerals encountered during drilling will be recorded by depth and adequately protected. All oil and gas shows will be tested to determine commercial potential.

3. Producing Formation Depth:

Objective Formations include the Wasatch 2,784'- 4,522'. Mesa Verde 4.522'-6.722° and the Castlegate 6,722-7050°.

4. Proposed Casing:

Hole	Casing			Coupling	Casing	
<u>Size</u>	<u>Size</u>	Weight/FT	Grade	& Tread	Depth	New/Used
$17 \frac{1}{2}$	13 3/8	48#	H-40	ST&C	300°	NEW
12 1/4	8 5/8	24#	J - 55	ST&C	2,500	NEW
7 7/8	$4\frac{1}{2}$	11.6#	N-80	LT&C	7,050°	NEW

Cement Program:

Surface casing will be cemented as follows from 0'-300': Note: Cement Volume = Gauge hole + 100%

	Casing	Cement	Cement	Cement	Water	Cement
	<u>Size</u>	<u>Type</u>	<u>Amounts</u>	<u>Yield</u>	<u>Mix</u>	<u>Weight</u>
Lead:	13 3/8"	Class "G" Ca Cl2 2% BWOC Floecele 1/4 # sk	360 sks +/-	1.15ft³/sk	5	15.8 ppg

Intermediate casing will be cemented as follows from 300'- 2,500':

Cement volume = Gauge hole + 50%

	Casing <u>Size</u>	Cement <u>Type</u>	Cement <u>Amounts</u>	Cement <u>Yield</u>	Water <u>Mix</u>	Cement <u>Weight</u>
Lead:						
	8 5/8"	Premium "5" 16% Gel 10#/sk Gilsonite 3% Salt 3#/sk GB3 0.25#/sk Flocele	300 sks. +/-	3.82ft³/sk	23	11.0 ppg
Tail:						
	8 5/8°°	Class "G" CaC12 2%BWOC Folocelc 1/4 #/sk	270 sks. +/-	1.15ft³/sk	5	15.8

Production casing will be cemented as follows from 2,500'- 7,050:

Note: Lead should be 200' above the Wasatch.

Cement volume = Gauge hole + 25%

	Casing <u>Size</u>	Cement <u>Type</u>	Cement <u>Amounts</u>	Cement <u>Yield</u>	Water <u>Mix</u>	Cement <u>Weight</u>
Lead:						
	4 1/2"	Premium "5" 16% Gel 10#/sk Gilsonite 3% Salt 3#/sk GB3 0.25#/sk flocele	190 sks. +/-	3.82ft³/sk	23	11.0 ppg
Tail:						
	4 ½"	Class "G" CaC12 2%BWOC Folocelc ¼ #/sk 50/50 POZ Salt 10% Gel 2%	460 sks. +/-	1.26ft³/sk	5.75	14.15

5. BOP and Pressure Containment Data:

A 3000-psi WP BOP system as described in the BOP and Pressure Containment Data (attached) will be installed and maintained from the 17 ½ " surface casing. An upper kelly cock to the required pressure rating with a handle available shall be employed.

The BOP system including the casing will be pressure tested to minimum standards set forth in "On Shore Order #2". The BOP will be mechanically checked daily during the drilling operation.

6. Mud Program:

<u>Interval</u>	Mud weight <u>lbs./gal.</u>	Viscosity <u>Sec./OT.</u>	Fluid Loss Ml/30 Mins.	<u>Mud Type</u>
0-2,500 2,500-T.D.	Air/Clear Water 8.4-12.0	 30-45	No Control 8-10	Water/Gel LSND
T. 7 . 7			14	aler hased mud sverem

Note: Mud weights may exceed 12.0 due to solids increasing at or near T.D. Increased weights are not required to control formation pressure. Operator will have on location sufficient mud and weight material to increase mud weight to 12.0 at any time while drilling the subject well. Visual mud monitoring incorporating pit level indicators shall be used.

7. Testing, Coring, Sampling and Logging:

a) DST:

None are anticipated.

b) Coring:

None are anticipated.

c)

Mud Sampling: Every 10' from 2,500' to T.D.

d) Logging:

Type

Interval

DIL W/GR and SP

T.D. to Surf. Csg FDC/CNL W/GR and CAL T.D. to Surf. Csg

e) Mud Logging:

Manned Unit

500' to T.D.

8. Abnormalities (including sour gas)

Anticipated bottom hole pressure will be less than 3000 psi. No abnormal pressures, temperatures or other hazards are anticipated. Other wells drilled in the area have not encountered over pressured zones or H2S.

9. Other facets of the proposed operation: Off set well information:

Producing Wells: FED H 12-30


Shut in Wells: FED H 14-30

Abandoned Wells: Southman Canyon U-6


10. Drilling Schedule:

The anticipated starting date is upon approval. Duration of operations is expected to be 30 days.

typical 3.000 psi. Elowout Preyenter Schenatic

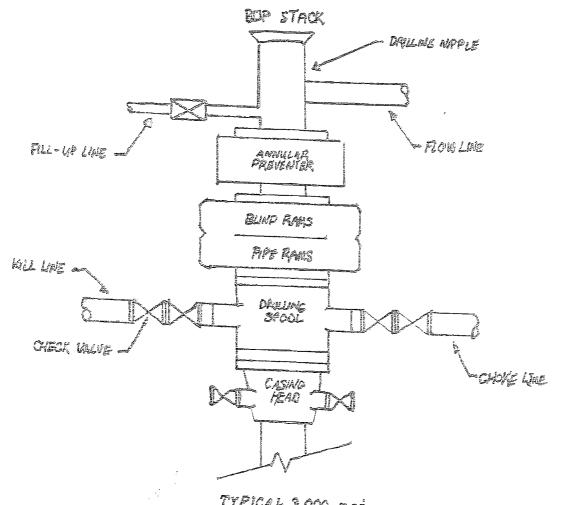

TYPICAL 3,000 ZEIL CHOKE MANIFOLD SCHEMATIC

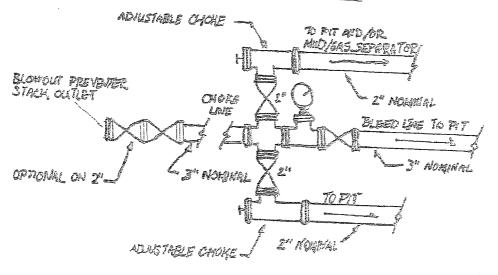

SUMMIT OPERATING LLC 13 POINT SURFACE USE PLAN

FOR WELL

MARIE 666

LOCATED IN SE 1/4 SW 1/4

SECTION 19, T.10S, R24E, S.L.B.&M.

UINTAH COUNTY, UTAH

LEASE NUMBER: UTU-065371

SURFACE OWNERSHIP: FEDERAL

1. Existing Roads:

Summit Operating, LLC Marie 666 Section 19, T10S, R24E

From the intersection of US Highway 40 and 500 East Street in Vernal, Utah proceed in an easterly then southerly direction along US highway 40 approximately 3.3 miles to the junction of State Highway 45; exit right and proceed in a southerly direction along state road (County B Road 4180). This road is located approximately 4.5 miles south of Bonanza, UT; exit left and proceed in a southwesterly direction along County B Road 4180 approximately 4.0 miles to the junction of the Kings Wells Road (County B Road 4190). Exit right and proceed in a southwesterly direction along the county B road 4190 approximately 8.1 miles to the intersection of the East Fork Asphalt Wash Road (County B Road 4250); exit right and proceed in a northeasterly direction along County B Road 4250 approximately 5.8 miles to the intersection of the Asphalt Wash Road (County B Road 4160); exit right and proceed along county b road 4160 in a northerly direction approximately 3.3 miles to the proposed access road. Follow road flags in an easterly, then northerly direction approximately 5430' to the proposed location.

Total distance from Vernal, Utah to the proposed well location is approximately 66.0 miles in a southeasterly direction.

All existing roads to the proposed location are State of Utah, BLM maintained or County Class D roads. Please see the attached map for additional details.

2. Planned access road

The proposed access road will be approximately 5,430° of new construction. Approximately feet of new construction will be off lease. The road will be graded once per year minimum and maintained.

A) Approximate length	5430 ft
B) Right of Way width	30 ft
C) Running surface	10 ft
D) Surface material	Native soil
E) Maximum grade	8%
F) Fence crossing	None
G) Culvert	
Culverts will be inst	alled as
necessary along acco	ess road.
H) Turnouts	None
I) Major cuts and fills	None
J) Road Flagged	Yes
K) Access road surface	ownership
	Federal
L) All new construction	n on lease
	No

No

M) Pipe line crossing None

Please see the attached location plat for additional details.

An off lease right-of-way will be required for approximately 1,100'

All surface disturbances for the road and location will not be within the lease boundary.

3. Location of existing wells

The following wells are located within a one-mile radius of the location site.

A) Producing well Fed H 12-30

B) Water well

None

C) Abandoned well
Soutman Canyon U-6

D) Temp. abandoned well

None

E) Disposal well

None

F) Drilling /Permitted well

None

G) Shut in wells Fed H 14-30

H) Injection well

None

I) Monitoring or observation well

None

Please see the attached map for additional details.

4. Location of tank batteries, production facilities and production gathering service lines.

All production facilities are to be contained within the proposed location site. Please see the attached plat plan for a typical gas well separator installation and well site piping.

All permanent (on site for more than six months or longer) structures constructed or installed will be painted a Olive Black color. Facilities required to comply with O.S.H.A. (Occupational Safety and Health Act) will be excluded. The required paint color is Olive Black.

All tanks will be surrounded by a dike of sufficient capacity to contain the storage capacity of the largest

tank in the battery. The integrity of the dike will be maintained.

The operator will adhere to all site security guidelines and regulation identified in 43 CFR 3126.7.

All off lease storage, off lease measurement, commingling on lease or off lease, of production, will have prior written approval form the authorized officer.

If the well is capable of economic production a surface gas line will be required.

Approximately 7,320' of 4" steel surface gas gathering line would be constructed on Federal Lands. The line is proposed as surface due to topography, sensitive soils and bedrock sandstone. The line will tie into an existing 4" pipeline in Section 30, T10S, R24E. The pipeline would be strung and boomed adjacent to the access road. A 15' permanent right-of-way will be required and a 30' right-of-way will be necessary during construction for one week.

An off lease right-of-way will be required for approximately 2,000'.

Please see the attached location diagrams for pipeline location.

The gas meter run will be located within 500' of the wellhead. The gas line will be buried or anchored down from the wellhead to the meter.

Meter runs will be housed and/or fenced.

The gas meter will be calibrated and the tank strapped in place prior to any deliveries. Tests for meter accuracy will be conducted monthly for the first three months on new meter installations and at least quarterly thereafter. The authorized officer will be provided with a date and time for the initial meter calibration and all future meterproving schedules. A copy of the meter calibration report will be submitted to the BLM's Vernal District office and State of Utah. Division of Oil, Gas, and Mining. All measurement facilities will conform to API (American Petroleum Institute) and AGA (American Gas Association) standards for gas and liquid hydrocarbon measurement.

5. Location and type of water supply

Water for drilling and cementing will come from a municipal source at Dalbo/A-1 Tanks in Vernal, UT at 355 South 1000 East.

6. Source of construction materials

All construction material for this location site and access road shall be borrow material accumulated during construction of the location site and access road. Additional road gravel or pit lining material will be obtained from private resources.

Methods for handling waste disposal A) Pit construction and liners:

The reserve pit will be approximately 10 ft. deep and most of the depth shall be below the surface of the existing ground Please see the attached plat for details.

The reserve pit will be lined.

The reserve pit will be used to store water for drilling. A semi-closed system will be used to drill the well. All fresh water for drilling will come from a frac tank placed on location and from the rig tank. The pit will be used to hold non-flammable materials such as cuttings, salt, drilling fluids, chemicals, produced fluids, etc.

B) Produced fluids:

Produced water will be confined to the reserve pit or, if deemed necessary, a storage tank for a period not to exceed 90 days after initial production. During the 90-day period an application for approval for permanent disposal method and location will be submitted to the authorized officer. Evaporation may be used instead of trucking to facilitate closing and reclamation of the reserve pit. A pumping system would be used for evaporation.

C) Garbage:

A trash cage fabricated from expanded metal will be used to hold trash on location and will be removed to an authorized landfill location.

D) Sewage:

A portable chemical toilet will be supplied for human waste.

E) Site clean-up:

After the rig is moved off the location the well site area will be cleaned and all refuse removed.

8. Ancillary facilities

There are no ancillary facilities planned at this time and none are foreseen for the future.

9. Well-site layout

Location dimensions are as follows:

A) Pad length	325 ft.
B) Pad width	155 ft.
C) Pit depth	10 ft.
D) Pit length	180 ft.
E) Pit width	50 ft.
F) Max cut	21.8 ft.
G) Max fill	10.6 ft.
H) Total cut yds.	11,490
I) Pit location	North end
J) Top soil location	
RI a not-b	R. Couth anda

North & South ends

K) Access road location

South end

L) Flare Pit

Corner B

(The reserve pit calculations reflect a 10' wide bench around the exterior of the pit.)

Please see the attached location diagram for additional details.

All pits will be fenced according to the following minimum standards:

- A) Thirty nine inch net wire shall be used with at least one strand of wire on top of the net wire. Barbed wire is not necessary if pipe or some type of reinforcement rod is attached to the top of the entire fence.
- B) The net wire shall be no more than 2 inches above the ground. The barbed wire shall be 3 inches above the net wire. Total height of the fence shall be at leas 42 inches.
- C) Corner posts shall be cemented and/or braced in such a manner to keep the fence tight at all times.
- D) Standard steel, wood or pipe posts shall be used between the corner braces. Maximum distance between any two posts shall be no greater than 16 ft.
- E) All wire shall be stretched by using a stretching device before it is attached to the corner posts.
- 10. Plans for restoration of the surface

Prior to construction of the location, the top 6 inches of soil material will be stripped off the location and the pit area. The topsoil removed and piled will amount to approximately 1,140 cubic yards of material. Topsoil will be stockpiled in one distinct pile. Placement of the topsoil is noted on the attached location plat. The topsoil pile from the location will be seeded as soon as the soil is stock piled with the seed mix listed. When all drilling and completion activities have been completed and the pit back-filled the topsoil from the pit area will be spread on the pit area. The pit area will be seeded when the soil has been spread. The unused portion of the location (the area outside the dead men) will be recontoured.

The dirt contractor will be provided with an approved copy of the surface use plan prior to construction activities.

Changes to the drainage during the construction activities shall be restored to its original line of flow or as near as possible when the pit is back-filled.

All disturbed areas will be recontoured to the approximate natural contours. Prior to back filling the pit the fences around the reserve pit will be removed.

The reserve pit will be reclaimed within 90 days of well completion. If the reserve pit has not dried sufficiently to allow back filling, an extension on the time requirement for back filling the pit will be requested. Once reclamation activities have begun, they shall be completed within 30 days.

After the reserve pit has been reclaimed, no depressions in the soil covering the reserve pit will be allowed. The objective is to keep seasonal rainfall and run off from seeping into the soil used to cover the reserve pit. Diversion ditches and water bars will be used to divert the run off as needed.

When restoration activities have been completed, the location site and new access road cuts and shoulders shall be reseeded. Prior to reseeding, all disturbed areas will be scarified and left with a rough surface.

A) Seeding dates:

Seed will be spread when topsoil is stock piled and when reclamation work is performed.

The seed mix and quantity list will be used whether the seed is broadcast or drilled.

B) Interim Seed Mix

4#/acre Indian Rice Grass 4#/acre Crested Wheat Grass 4#/acre Needle & Thread Grass

11. Surface ownership:

Access road Federal Location Federal Pipe line Federal

12. Other information:

A) Vegetation

The vegetation coverage is slight. The majority of the existing vegetation consists of non-native species. Rabbit brush, bitter brush, and Indian Rice grass and Sagebrush were also found on the location.

B) Dwellings:

There are no dwellings or other facilities within a one-mile radius of the location.

C) Archeology:

The location has not been surveyed, however, has been ordered. The survey will be forwarded to your office as soon as it has been completed.

If, during operations, any archaeological or historical sites, or any objects of antiquity (subject to the antiquities act of June 8, 1906) are discovered, all operations, which would affect such sites, will be suspended and the discovery reported promptly to the surface management agency.

D) Water:

The nearest water is the White River located 1.5 miles +/- to the North.

E) Chemicals:

No pesticides, herbicides or other possible hazardous chemicals will be used without prior application.

F) Notification:

- a) Location Construction
 At least forty eight (48)
 hours prior to
 construction of location
 and access roads.
- b) Location completion prior to moving on the drilling rig.
- c) Spud notice
 At least twenty-four (24)
 hours prior to spudding
 the well.
- d) Casing string and cementing
 At least twenty-four (24) hours prior to running casing and cementing all casing strings.
- e) BOP and related equipment tests At least twenty-four (24) hours prior to initial pressure tests.
- f) First production notice Within five (5) business days after the new well begins, or production resumes after well has been off production for more than 90 days.

G) Flare pit:

The flare pit will be located in corner B of the reserve pit out side the pit fences and 100 feet from the bore hole on the east side of the location. All fluids will be removed from the pit within 48 hours of occurrence.

- 13. Lessees or Operator's representative and certification
 - A) Representative

Ginger Stringham Paradigm Consulting PO BOX 790203 Vernal, UT 84079

Office 435-789-4162 Fax 435-789-8188 Cellular 435-790-4163

All lease and/or unit operations will be conducted in such a manner that full compliance is made with all applicable laws, regulations, onshore oil and gas orders, and any applicable notices to lessees. The operator is fully responsible for the actions of his subcontractors. A copy of these conditions will be furnished to the field representative to ensure compliance. This drilling permit will be valid for a period of one year from the date of approval. After permit termination, a new application will be filed for approval for any future operations.

B) Certification:

I hereby certify that I, or persons under my direct supervision, have inspected the proposed drill-site and access route that I am familiar with the conditions which presently exist, that the statements made in this plan are, to the best of my knowledge and belief, true and correct, and that the work associated with the operation

proposed herein will be preformed by Summit Operating, LLC and its contractors and subcontractors in conformity with this plan and terms and conditions with this plan and the terms and conditions under which it is approved. This statement is subject to the provisions of 18 U.S.C. 1001 for filing of a false statement.

Onsite Dates: 3/8/07

Self Certification Statement

The following self-certification statement is provided per Federal requirements dated June 15, 1988.

Please be advised that Summit Operating, LLC is considered to be the operator of the following well:

Marie 666
Section 19, T. 10S, R. 24E
SE ¼ of the SW ¼
Lease UTU-065371
Uintah County, Utah

The Summit Operating, LLC is responsible under the terms and conditions of the lease for the operations conducted upon the lease lands.

Bond UTB-000014 provides state-wide bond coverage on all Federal Lands.

Ginger Stringham, Agent
Paradigm Consulting, INC

Date 8/4/07

Statement of use of Hazardous Materials

No chemical(s) from the EPA's consolidated list of Chemicals Subject to Reporting under Title III of the Superfund Amendments and Reauthorization, Act (SARA) of 1986 will be used, produced, transported, stored, disposed, or associated with the proposed action. No extremely hazardous substances, as defined in 40 CFR 355, will be used, produced, stored, transported, disposed, or associated with the proposed action.

If you require additional information please contact:

Paradigm Consulting, INC Ginger Stringham, Agent for Summit Operating, LLC PO BOX 790203 Vernal, UT 84079

435-789-4162 Office 435-789-8188 Fax

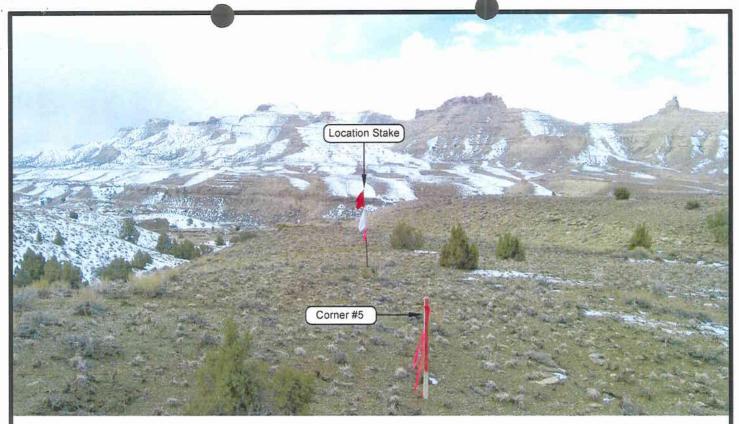


PHOTO VIEW: FROM CORNER #5 TO LOCATION STAKE

CAMERA ANGLE: SOUTHWESTERLY



PHOTO VIEW: FROM BEGINNING OF PROPOSED ROAD

CAMERA ANGLE: NORTHEASTERLY

SUMMIT OPERATING, LLC

Marie 666 SECTION 19, T10S, R24E, S.L.B.&M. 539' FSL & 1719' FWL

LOCATION	PHOTOS

DATE TAKEN: 02-27-07 DATE DRAWN: 02-28-07


TAKEN BY: M.S.B.


DRAWN BY: M.W.W.

SHEET

Timberline Land Surveying, Inc. 38 West 100 North Vernal, Utah 84078 (435) 789-1365

1 OF 10

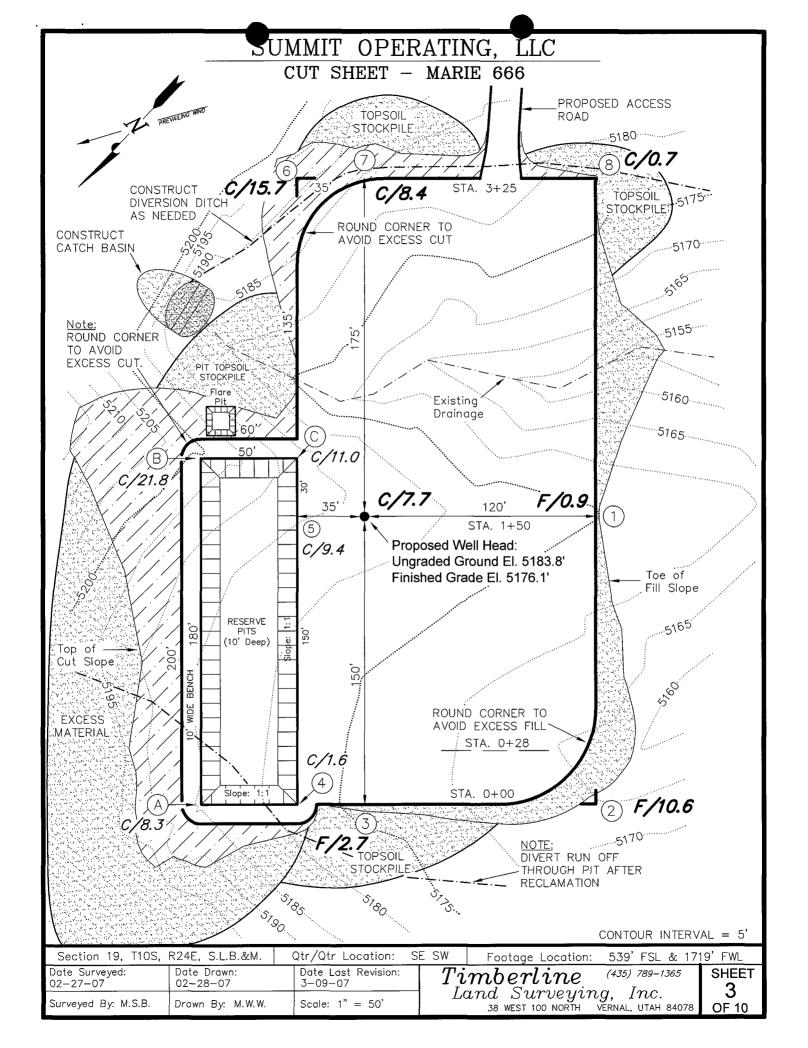

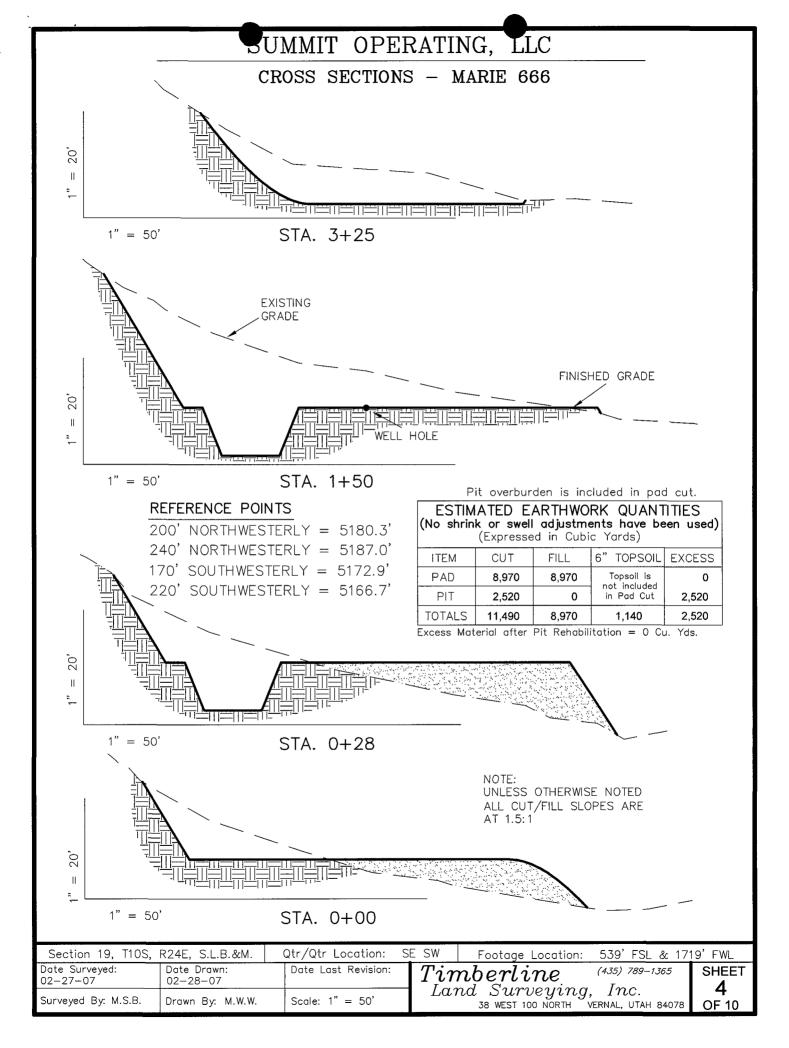



SUMMIT OPERATING, LLC TYPICAL RIG LAYOUT - MARIE 666 PROPOSED ACCESS ROAD 50' DOG HOUSE 35 120' WATER RIG MUD TANKS 150 PUMP VOLUME: 9,100 bbls W / 2' Freeboard TOILET [RESERVE PITS MUD SHED 200, HOPPER POWER TOOLS FUEL STORAGE TANK / Slope: 1:1


Section 19, T10S,	R24E, S.L.B.&M.	Qtr/Qtr Location: S	SE SW	Footage Location: 539' FSL & 1	719' FWL
Date Surveyed: 02-27-07	Date Drawn: 02-28-07	Date Last Revision:		nberline (435) 789-1365	SHEET
Surveyed By: M.S.B.	Drawn By: M.W.W.	Scale: 1" = 50'		nd $Surveying,\ Inc.$ 38 west 100 north $\ \ \ \ \ \ \ \ \ \ \ \ \ \ \ \ \ \ \$	OF 10


SUMMIT OPERATING, LLC TYPICAL PRODUCTION LAYOUT - MARIE 666 WELL HEAD Insulated 2" Flow line PIT AREA 2 300 bbl Tanks & Berm Separator, Dehydrator & Dump Lines

Section 19, T10S,	R24E, S.L.B.&M.	Qtr/Qtr Location:	SE SW	Footage Location: 539' FSL & 1	719' FWL
Date Surveyed: 02-27-07	Date Drawn: 02-28-07	Date Last Revision:		nberline (435) 789–1365	SHEET
Surveyed By: M.S.B.	Drawn By: M.W.W.	Scale: 1" = 50'	Lan	$nd\ Surveying,\ Inc.$ 38 West 100 North Vernal, utah 84078	OF 10

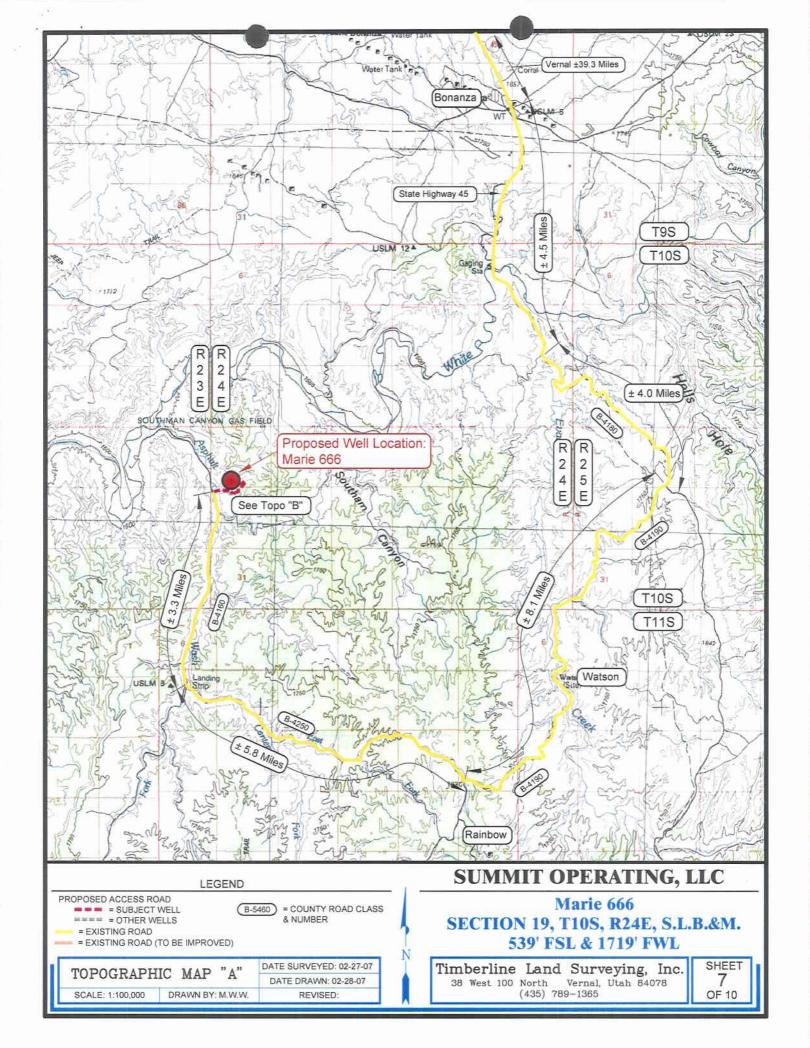

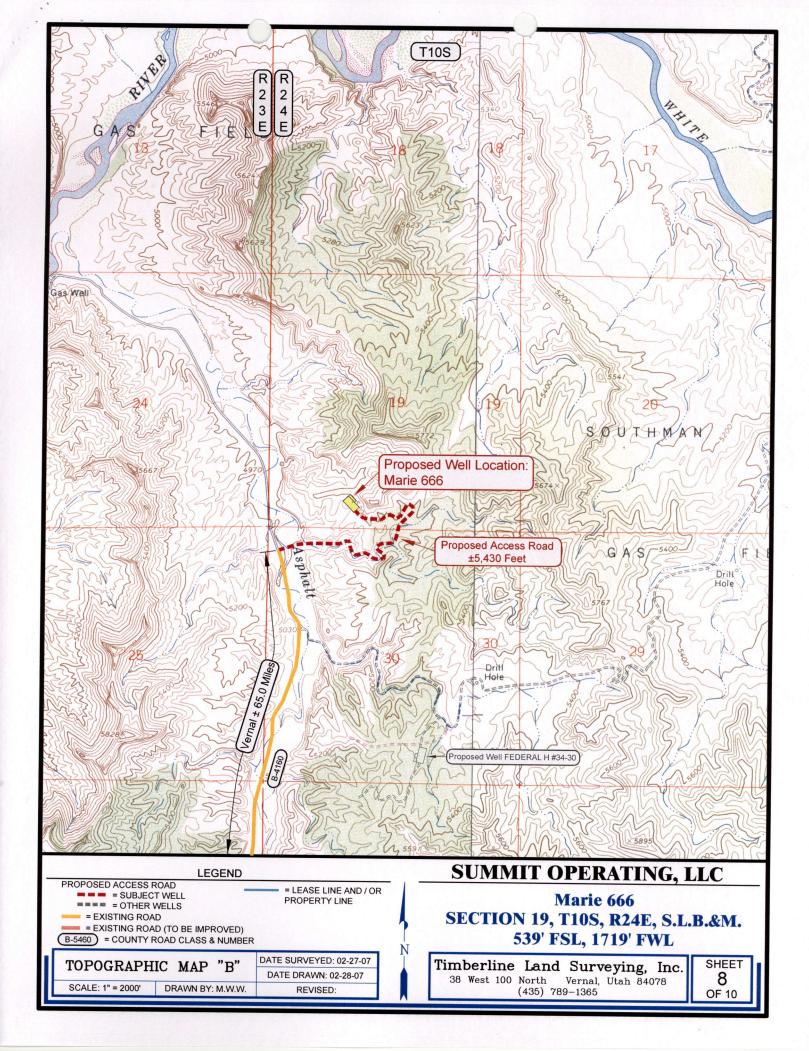

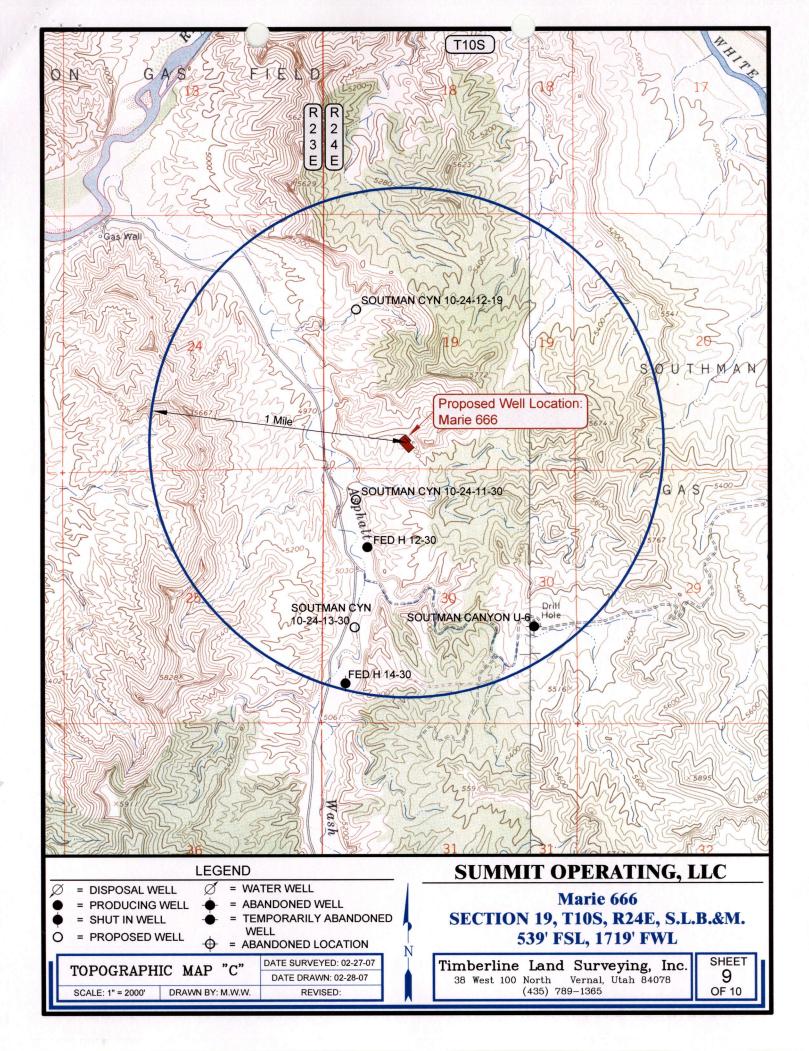

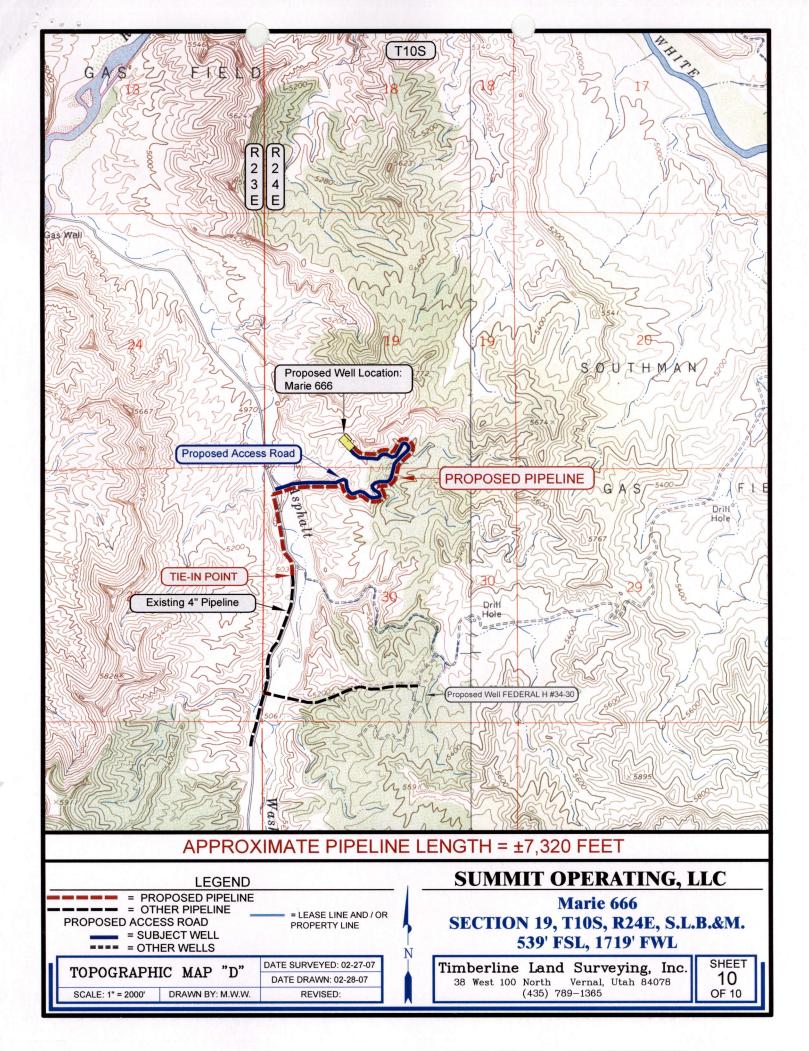

APD RECEIVE	D: 03/19/2007		API NO. ASSIG	NED: 43-04	7-39154
WELL NAME:	MARIE 666				
	SUMMIT OPERATING, LLC (N2315)		PHONE NUMBER:	435-940-900	1
	GINGER STRINGHAM				
PROPOSED LC	CATION:		INSPECT LOCATN	BY: /	/
	L9 100S 240E 0539 FSL 1719 FWL		Tech Review	Initials	Date
	0539 FSL 1719 FWL		Engineering		
COUNTY:	UINTAH 39.92875 LONGITUDE: -109.2592		Geology		
	EASTINGS: 648753 NORTHINGS: 44210	90	Surface		
FIELD NAM	E: NATURAL BUTTES (630)		<u> </u>	
LEASE NUMBE	1 - Federal R: UTU-065371 ER: 1 - Federal		PROPOSED FORMAT		GT
RECEIVED AN	D/OR REVIEWED:	LOCATI	ON AND SITING:		
V Plat			640.0.3		
	Fed[1] Ind[] Sta[] Fee[]	ĸ	649-2-3.		
	UTB-000014)	Unit:_			
. f	sh (Y/N)	R	649-3-2. Gener	al	
oil s	hale 190-5 (B) or 190-3 or 190-13	s	iting: 460 From Qt	r/Qtr & 920' E	setween Wells
_	Permit	R	649-3-3. Excep	tion	
	MUNICIPAL)	D	rilling Unit		
	Review (Y/N)		Board Cause No:		
(Dat			Eff Date:		
	urf Agreement (Y/N)	•	Siting:		
<u></u> ✓ Inten	t to Commingle (Y/N)	R	649-3-11. Dire	ctional Dri	11
COMMENTS: _					
STIPULATION	is: 1- foder 0	pprvol	\bigcirc		
	2- Space	Sir			
					

BHI 10-24-14-18 SOUTHAM CYN 10-24-14-17 SOUTHAM CYN 10-24-14-18

T10S R23E | T10S R24E

NATURAL BUTTES FIELD

FED H 12-19

SOUTHMAN CYN 10-24-12-19

15

MARIE 666

SOUTHMAN CYN 10-24-11-30

FED H 12-30

OPERATOR: SUMMIT OPER (N2315)

SEC: 19 T.10S R. 24E

FIELD: NATURAL BUTTES (630)

COUNTY: UINTAH

SPACING: R649-3-3 / EXCEPTION LOCATION

- Field Status

 ABANDONED

 ACTIVE

 COMBINED

 INACTIVE

 PROPOSED

 STORAGE

 TERMINATED
- Unit Status
 EXPLORATORY
 GAS STORAGE
 NF PP OIL
 NF SECONDARY
 PENDING
 PI OIL
 PP GAS
 PP GEOTHERML
 PP OIL
 SECONDARY

TERMINATED

- Wells Status

 GAS INJECTION
 GAS STORAGE
 LOCATION ABANDONED
 NEW LOCATION
- PRODUCING GAS
 PRODUCING OIL
- SHUT-IN GAS
 SHUT-IN OIL
 TEMP. ABANDONED
- TEST WELL

 WATER INJECTION
- WATER SUPPLY
 WATER DISPOSAL
 DRILLING





PREPARED BY: DIANA MASON DATE: 26-MARCH-2007



State of Utah

Department of Natural Resources

MICHAEL R. STYLER Executive Director

Division of Oil, Gas & Mining

JOHN R. BAZA
Division Director

JON M. HUNTSMAN, JR. Governor

GARY R. HERBERT Lieutenant Governor

March 28, 2007

Summit Operating, LLC P O Box 683909 Park City, UT 84068

Re:

Marie 666 Well, 539' FSL, 1719' FWL, SE SW, Sec. 19, T. 10 South,

R. 24 East, Uintah County, Utah

Gentlemen:

Pursuant to the provisions and requirements of Utah Code Ann.§ 40-6-1 *et seq.*, Utah Administrative Code R649-3-1 *et seq.*, and the attached Conditions of Approval, approval to drill the referenced well is granted.

Appropriate information has been submitted to DOGM and administrative approval of the requested exception location is hereby granted.

This approval shall expire one year from the above date unless substantial and continuous operation is underway, or a request for extension is made prior to the expiration date. The API identification number assigned to this well is 43-047-39154.

Sincerely,

Gil Hunt

Associate Director

pab Enclosures

cc:

Uintah County Assessor (via e-mail)

Bureau of Land Management, Vernal District Office

Operator:	Summit Operating, LLC					
Well Name & Number	Marie 666					
API Number:	43-047-39154 UTU-065371					
Location: SE SW	Sec. 19	T. 10 South	R. 24 East			

Conditions of Approval

1. General

Compliance with the requirements of Utah Admin. R. 649-1 *et seq.*, the Oil and Gas Conservation General Rules, and the applicable terms and provisions of the approved Application for permit to drill.

2. Notification Requirements

Notify the division within 24 hours of spudding the well.

• Contact Carol Daniels at (801) 538-5284.

Notify the Division prior to commencing operations to plug and abandon the well.

• Contact Dustin Doucet at (801) 538-5281

3. Reporting Requirements

All required reports, forms and submittals will be promptly filed with the Division, including but not limited to the Entity Action Form (Form 6), Report of Water Encountered During Drilling (Form 7), Weekly Progress Reports for drilling and completion operations, and Sundry Notices and Reports on Wells requesting approval of change of plans or other operational actions.

- 4. State approval of this well does not supersede the required federal approval, which must be obtained prior to drilling.
- 5. This proposed well is located in an area for which drilling units (well spacing patterns) have not been established through an order of the Board of Oil, Gas and Mining (the "Board"). In order to avoid the possibility of waste or injury to correlative rights, the operator is requested, once the well has been drilled, completed, and has produced, to analyze geological and engineering data generated therefrom, as well as any similar data from surrounding areas if available. As soon as is practicable after completion of its analysis, and if the analysis suggests an area larger than the quarter-quarter section upon which the well is located is being drained, the operator is requested to seek an appropriate order from the Board establishing drilling and spacing units in conformance with such analysis by filing a Request for Agency Action with the Board.

Form 3160-5 (February 2005)

UNITED STATES DEPARTMENT OF THE INTERIOR BUREAU OF LAND MANAGEMENT

SUNDRY NOTICES AND REPORTS ON WELLS

FORM APPROVED
OM B No. 1004-0137
Expires: March 31, 2007

5. Lease Serial No. UTU-065371

Do not use the abandoned w	nis form for proposals t ell. Use Form 3160-3 (<i>)</i>	o drill or to re APD) for such p	e-enter an proposals.	6. If india	n, Anottee of Thoe Name		
SUBMIT IN TRIPLICATE- Other instructions on reverse side.					or CA/Agreement, Name and/or No.		
1. Type of Well Gas Well Other 2. Name of Operator Summit Operating, LLC					8. Well Name and No. Marie 666		
3a Address	raing, DDC	3b. Phone No. (incl.	ude area code)	9. API W 43047			
PO BOX 683909 Park City, U	Т 84068	435-940-9001	ance area coacy	10. Field a	nd Pool, or Exploratory Area		
4. Location of Well (Footage, Sec.,	T., R., M., or Survey Description)				al Buttes		
539' FSL & 1719' FWL	Sec. 19, T10S, R24E		•	Uintal	or Parish, State		
12. CHECK A	PPROPRIATE BOX(ES) TO	INDICATE NATI	URE OF NOTICE,	REPORT, O	R OTHER DATA		
TYPE OF SUBMISSION		T	YPE OF ACTION				
Notice of Intent Subsequent Report Final Abandonment Notice	Acidize Alter Casing Casing Repair Change Plans Convert to Injection	Deepen Fracture Treat New Construction Plug and Abandon Plug Back	Reclamation Recomplete	; y Abandon	Water Shut-Off Well Integrity Other		
following completion of the inv testing has been completed. Fit determined that the site is ready	volved operations. If the operation is all Abandonment Notices must be	results in a multiple coi filed only after all requ	mpletion or recomplet irements, including re	ion in a new intervention in a new intervention, have be			
Grade: N-80 Coupling and Tread: LT& Casing depth: 7,050 New COPY SENT TO OFE Doile: LF 06/07 Initiols: CHID	Oil,	cepted by the tah Division Gas and Mi	he of ning		proval Of This Necessary		
14. Thereby certify that the fore Name (Printed/Typed)	going is true and correct		7				
Ginger Bowden		Title	Agent		and the second s		
Signature Timage	Bruden	Date		10/17/2007			
4 9	THIS SPACE FOR F	EDERAL OR	STATE OFFI	CE USE			
Approved by Conditions of approval, if any, are a certify that the applicant holds legal which would entitle the applicant to Title 18 U.S.C. Section 1001 and Title	or equitable title to those rights in conduct operations thereon.	the subject lease	Title Office knowingly and willf		Date y department or agency of the United		
States any false, fictitious or fraudul	ent statements or representations a	s to any matter within	its jurisdiction.				

(Instructions on page 2)

OCT 19 2007

STATE OF UTAH

DEPARTMENT OF NATURAL RESOURCES DIVISION OF OIL, GAS AND MINING

VU	C. Leave		THE PERSON NAMED IN				100			
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FORM 9

DIVISION OF	OIL, GAS AND MIN	NING	5. LEASE DESIGNATION AND SERIAL NUMBER: UTU-65371
SUNDRY NOTICES	AND REPORTS	ON WELLS	6. IF INDIAN, ALLOTTEE OR TRIBE NAME:
Do not use this form for proposals to drill new wells, significantly of drill horizontal laterals. Use APPLICAT	eepen existing wells below cum ION FOR PERMIT TO DRILL fo	ent bottom-hole depth, reenter plugged wells, or to orm for such proposals.	7. UNIT or CA AGREEMENT NAME:
1. TYPE OF WELL OIL WELL GAS W	ELL OTHER		8. WELL NAME and NUMBER: Marie 666
2. NAME OF OPERATOR: Summit Operating, LLC			9. API NUMBER: 4304739154
3. ADDRESS OF OPERATOR:		PHONE NUMBER:	10. FIELD AND POOL, OR WILDCAT:
PO Box 683909 CITY Park City 4. LOCATION OF WELL	STATE UT ZIP	84068-3909 (435) 940-9001	Asphalt Wash
FOOTAGES AT SURFACE: 539' FSL, 1719' FWL			соunтy: Uintah
QTR/QTR, SECTION, TOWNSHIP, RANGE, MERIDIAN: SES	SW 19 10S 24	4E	STATE: UTAH
11. CHECK APPROPRIATE BO	XES TO INDICATE	E NATURE OF NOTICE, REPOR	RT. OR OTHER DATA
TYPE OF SUBMISSION		TYPE OF ACTION	
✓ NOTICE OF INTENT		DEEPEN	REPERFORATE CURRENT FORMATION
(Submit in Duplicate) ALTER CASIN	3	FRACTURE TREAT	SIDETRACK TO REPAIR WELL
Approximate date work will start: CASING REPA	IR .	NEW CONSTRUCTION	TEMPORARILY ABANDON
CHANGE TO F	REVIOUS PLANS	OPERATOR CHANGE	TUBING REPAIR
CHANGE TUB	NG	PLUG AND ABANDON	VENT OR FLARE
SUBSEQUENT REPORT CHANGE WEL	NAME	PLUG BACK	WATER DISPOSAL
Date of work completion:	STATUS	PRODUCTION (START/RESUME)	WATER SHUT-OFF
COMMINGLE F	PRODUCING FORMATIONS	RECLAMATION OF WELL SITE	✓ OTHER: Request for extension
CONVERT WE	L TYPE	RECOMPLETE - DIFFERENT FORMATION	of APD
12. DESCRIBE PROPOSED OR COMPLETED OPERAT	TONS. Clearly show all per	rtinent details including dates, depths, volume	s, etc.
Summit Operating, LLC hereby requests time for the Federal APD approval to be	an extension of the given.	State APD date for 1 year for th	e Marie 666 Well, in order to allow
	Approved Utah Divis Oil, Gas and	by the sion of d Mining	
COPY SENT TO OPERATOR Date: 1-14-2009 Initials: 125	Date: Ol-I	0-08	
NAME (PLEASE PRINT) David Killy Mile /		TITLE Operations	
c - I ffeet		ONIEOUTODIOO	PECEIVED
This space for State use only)			114 0 2000
			JAN 1 0 2008

DIV. OF OIL, GAS & MINING

Application for Permit to Drill Request for Permit Extension Validation

(this form should accompany the Sundry Notice requesting permit extension)

API: 43-047-39154 Well Name: Location: Company Permit Issued to: Date Original Permit Issued:
The undersigned as owner with legal rights to drill on the property as permitted above, hereby verifies that the information as submitted in the previously approved application to drill, remains valid and does not require revision.
Following is a checklist of some items related to the application, which should be verified.
If located on private land, has the ownership changed, if so, has the surface agreement been updated? Yes□No□ NA
Have any wells been drilled in the vicinity of the proposed well which would affect the spacing or siting requirements for this location? Yes□No♥
Has there been any unit or other agreements put in place that could affect the permitting or operation of this proposed well? Yes□No汶
Have there been any changes to the access route including ownership, or right-of-way, which could affect the proposed location? Yes□No ☒
Has the approved source of water for drilling changed? Yes□Noば
Have there been any physical changes to the surface location or access route which will require a change in plans from what was discussed at the onsite evaluation? Yes□No⊠
Is bonding still in place, which covers this proposed well? Yes⊠No□
Signature Date
Title: New Market
Representing: Summit operating 1/6 JAN 1 0 200

JAN 1 0 2008



State of Utah

DEPARTMENT OF NATURAL RESOURCES

MICHAEL R. STYLER
Executive Director

March 19, 2009

Division of Oil, Gas and Mining

JOHN R. BAZA
Division Director

Summit Operating, LLC P.O. Box 683909 Park City, UT 84068-3909

Re:

APD Rescinded – Marie 666, Sec. 19 T. 10S, R. 24E Uintah County, Utah API No. 43-047-39154

Ladies and Gentlemen:

The Application for Permit to Drill (APD) for the subject well was approved by the Division of Oil, Gas and Mining (Division) on March 28, 2007. On January 10, 2008 the Division granted a one-year APD extension. No drilling activity at this location has been reported to the division. Therefore, approval to drill the well is hereby rescinded, effective March 19, 2009.

A new APD must be filed with this office for approval <u>prior</u> to the commencement of any future work on the subject location.

If any previously unreported operations have been performed on this well location, it is imperative that you notify the Division immediately.

Sincerely,

Diaha-Mason

Environmental Scientist

cc:

Well File

Bureau of Land Management, Vernal





United States Department of the Interior

BUREAU OF LAND MANAGEMENT Green River District

Vernal Field Office 170 South 500 East Vernal, UT 84078

http://www.blm.gov/ut/st/en/fo/vernal.html

NOV 04 2015

RECEIVED

NOV 1 0 2015

IN REPLY REFER TO: 3160 (UTG011)

DIV. OF OIL, GAS & MINING

Ellis Peterson Summit Operating, LLC 10447 South Jordan Gateway South Jordan, UT 84095

Dear Ellis:

The following Applications for Permit to Drill (APD) are being returned unapproved per your request to this office in an email message to Natural Resource Specialist Nicholas Day received on October 9, 2015. If you intend to drill at any of these locations at a future date, a new APD must be submitted.

Lease	Well		Aliquot	Sec., T., R.	Date Rec'd
UTU-65371	Marie 666	39154	SESW	Sec. 19, T10S-R24E	3/15/2007
UTU-10178A	SRU #12-22	39693	NWSW	Sec. 22-T13S-R22E	10/16/2007
UTU-10178A	SRU #14-22	39.709	SESW	Sec. 22-T13S-R22E	10/16/2007
UTU-6616	SRU #12-23	39111	NWSW	Sec. 23-T13S-R22E	10/16/2007
UTU-6616	SRU #14-23	39710	SESW	Sec. 23-T13S-R22E	10/16/2007
UTU-6616	SRU #10-26	39713	NWSE	Sec. 26-T13S-R22E	10/16/2007

If you have any questions regarding APD processing, please contact Robin R. Hansen at (435) 781-3428.

Sincerely,

/s/ Jerry Kenczka

Jerry Kenczka Assistant Field Manager Lands & Resource Minerals

Enclosures

CC: bcc: **UDOGM** Well File

1